

AND THE UNCONDITIONED SPACE OR EXTERIOR. - ATTIC VENTILATION SHALL ADHERE TO 9.19.1.2. (VENTILATION REQUIREMENTS) OF BCBC. - LIGHTING BY OTHERS. - CONCRETE TO REACH 3000 P.S.I. AFTER 28 DAYS OR ANY FAILURE OF THE STRUCTURE. NOISE LEVEL OF 2.5 SONES (60dBa) OR LESS.

- Floor assembly to accommodate plumbing. Framing Notes:

- Wall sheathing shall extend 1" past topo of slab. - Sheathing shall completely lap the adjoining wall at the intersection of the corners. - All built-up posts at point loads: each ply is to be nailed with 2 rows

- Posts shall be anchored to the beams they support by either-1. Notching the beam over the post and securely nailing or bolting the beam to the post. (depending on configuration and load) or 2. Provide approved suitable metal anchors to connect the two.

IMMEDIATELY & PRIOR TO THE COMMENCEMENT OF THE

TYPICAL NOTES

CONTRACTOR TO REPORT ALL ERRORS OR EMISSIONS

PORTABLE SHED 6.8m² (73 SF)

TO BÉ

REMOVED

5.15 m

2. ANY DISCREPENCIES TO BE BROUGHT TO THE OWNER'S ATTENTION PRIOR TO CONTINUING ANY PORTION OF

SEE STRUCTURAL DRAWINGS FOR ALL FOUNDATIONS, CONC. WALLS & SLABS, WOOD JOISTS & BEAM SIZES.

5. DIMENSIONS ARE IN IMPERIAL UNO.

6. PROVIDE MISCELLANEOUS STUDS, BRACING, FURRING OR

BLOCKING AS REQUIRED. MAINTAIN ACOUSTIC SEPARATION @ RECESSED FIXTURES

& EQUIPMENT. 8. CEMENT BOARD TO BE USED @ ALL WET WALLS.

9. CONFIRM WINDOW AND DOOR ROUGHOPEN SIZES WITH SUPPLIEERS. SIZES ON DRAWINGS ARE NOMINAL. OPENER STYLES & LOCATIONS TO BE DETERMINED BY OWNER.



THIS DESIGN IS NOT TO BE REPRODUCED, COPIED OR REUSED WITHOUT THE WRITTEN APPROVAL OF IMMERSIVE DESIGN INC. THIS DESIGN IS TO BE UTILIZED ONLY FOR THE SITE INTENDED AND DESIGNATED ON THE DRAWINGS. IMMERSIVE DESIGN INC. NOR THE DESIGNER/DRAFTSMAN ACCEPT ANY RESPONSIBILITY FOR THE FOLLOWING CONFORMITY OF PLANS TO THE SITE. ERRORS AND OMISSIONS, VARIOUS ENGINEERING REQUIREMENTS. ANY HOUSE BUILT FROM THESE PLANS. INFORMATION PROVIDED ON EXISTING BUILDINGS OR SITE. THESE PLANS ARE NOT TO BE REPRODUCED, COPIED OR REUSED WITHOUT THE WRITTEN APPROVAL OF IMMERSIVE DESIGN INC.

Project Name:

Detached Accessory Dwelling Unit

1034 DUNSMUIR Road Esquimalt, BC V9A 5C5

Sheet List Sheet Name Cover - Site Plan Views & Section

Elevations

Lateral Bracing & Details

6.6m


Cover - Site


Drawing No. Scale: as noted

Drawn by: AJW

A1

Date: APR. 10, 2024 File Name:

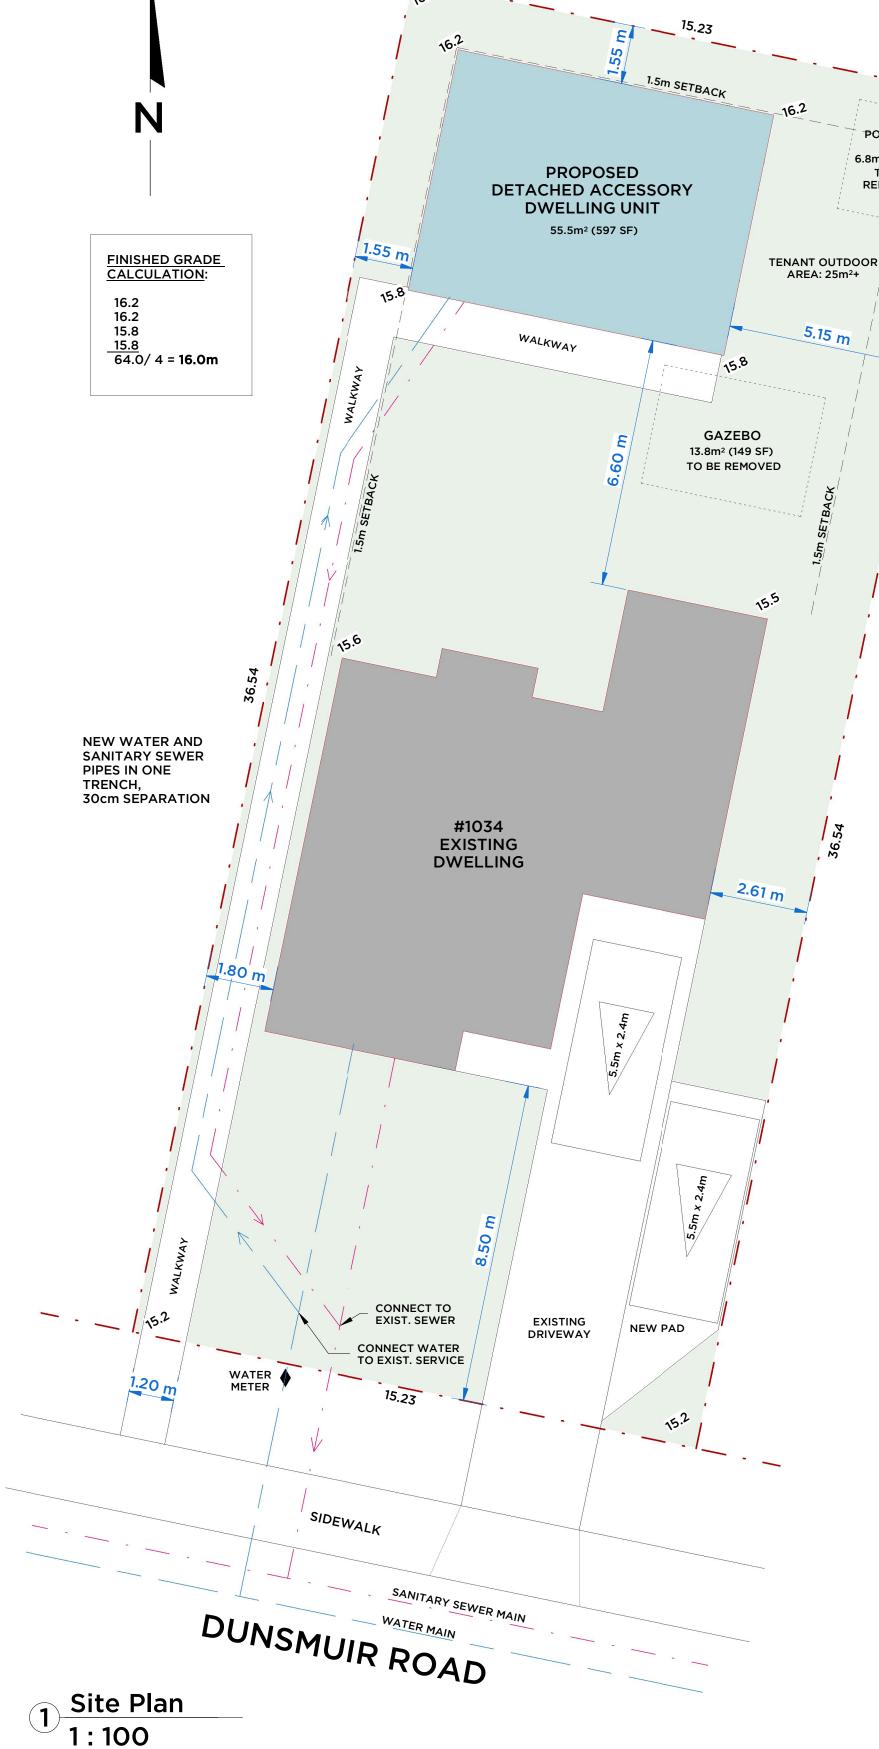

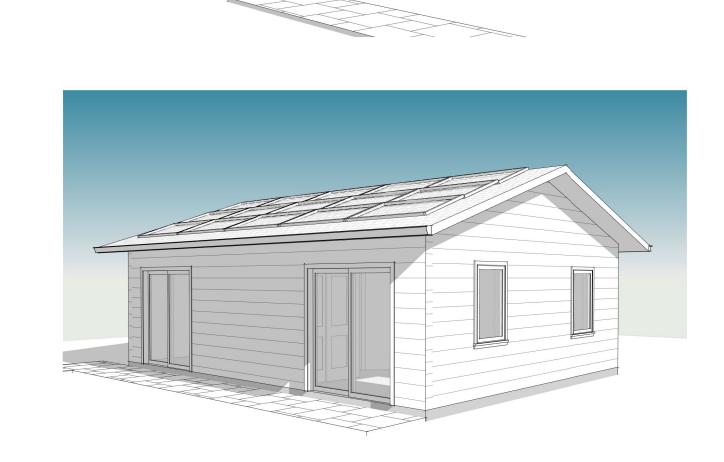

Lot 21, Block B, Section 11, Esquimalt District Plan 292

PID: 000-165-646

<u>Civic Address</u>: 1034 Dunsmuir Road Esquimalt, BC V9A 5C5

Site Synopsis

Zoning 556.5m² (5990 SF) Site area Rear Yard Area 223m² (2403 SF)

Floor Area

DADU 55.5m² (597 SF)

<u>Proposed</u> 3.33m **Building Height** <u>Lot Coverage</u> **Existing House** DADU & Accs. 20.6m² 9.9% (55.5m²) 25% 9.2% 24.9% Rear Yard 30% Total Coverage 22.8% 29.1% 167m² 121m² 161.8m²

Building Separation 2.5m

Proposed <u>Setbacks</u> Minimum 1.55m Rear Lot Line Side Lot Line (W) 1.55m 1.5m 1.5m Side Lot Line (E) 5.15m

GENERAL NOTES

- ALL WORK SHALL COMPLY TO THE CURRENT (2018) EDITION OF THE BRITISHCOLUMBIA BUILDING CODE AND SHALL MEET OD EXCEED THE MINIMUM REQUIREMENTS AS SET BY THOSE HAVING JURISDICTION. - ERRORS, OMISSIONS OR CHANGES TO THESE PLANS ARE TO BE REPORTED TO THE DESIGNER PROMPTLY PRIOR TO ANY FURTHER WORK TAKING PLACE. - STRUCTURAL DESIGN & SUPERVISION SHALL BE PERFORMED BY A CERTIFIED STRUCTURAL ENGINEER CERTIFIED IN THE PROVINCE OF BRITISH COLUMBIA AT THE REQUEST OF THE LOCAL BUILDING AUTHORITY. FOUNDATIONS TO BE VERIFIED CORRECT BY A STRUCTURAL

ENGINEER UNLESS OTHERWISE APPROVED BY THE BUILDING INSPECTION AUTHORITY. - ALL FOUNDATIONS ARE ASSUMED BEARING ON NON-ORGANIC - POINT LOADS TO BE SUPPORTED CONTINUOS TO FOUNDATION. - DOUBLE JOISTS OR SOLID CROSS BLOCKS AT WALL LOCATIONS RUNNING PARALLEL TO FLOOR JOISTS. - LINTELS TO BE 3-PLY 2"x10" SPF#2 OR AS NOTED.

- BUILDING ENVELOPE DESIGN TO BE BASED ON CURRENT GOOD BUILDING PRACTICES. FIELD INSPECTIONS ARE THE RESPONSIBILITY OF THE OWNER. PREMANUFACTURED FLOOR JOISTS, BEAMS AND TRUSSES TO BE REVIEWED BY SUPPLIER'S ENGINEER AND CERTIFIED FOR STRUCTURAL ADEQUACY. SUPPORTING COLUMNS TO BE

DESIGNED BY A STRUCTURAL ENGINEER AT THE REQUEST OF THE LOCAL BUILDING INSPECTION AUTHORITY. ENGINEERED ROOF TRUSSES, FLOOR JOIST AND BEAM SYSTEM LAYOUTS TO BE PROVIDED WITH SHOP DRAWINGS FOR PERMIT - 110 VOLT INTERCONNECTED SMOKE DETECTOR & CARBON MONOXIDE DETECTOR THESE DRAWINGS ARE BASED ON PART 9 OF THE 2018 BCBC - DUCTING, FURNACE, HOT WATER HEATER TO BE LOCATED WITHIN CONDITIONED AREAS. - INSULATION VALUES TO MEET THE EFFECTIVE R-VALUES AS NOTED IN BCBC 9.36.2.6.-9.36.2.8. ANS AS REQUIRED BY

THOSE HAVING JURISDICTION.

HEATING AND VENTILATION TO MEET NEW MINIMUM

CODE REQUIREMENTS UNLESS NOTED OTHERWISE.

- ALL CHASE WAYS, DUCTING & PIPING LOCATED IN NON-CONDITIONED AREAS MUST HAVE THE MINIMUM EFFECTIVE R-VALUE OF INSULATION BETWEEN IT


- ALL STRUCTURAL LUMBER TO BE NO.2 OR BETTER. - DESIGNER IS NOT RESPONSIBLE FOR THE STRUCTURE, - FANS TO BE RATED FOR CONTINUOUS USE WITH A - ALL BATHROOMS AND KITCHENS TO BE EQUIPPED WITH AN EXHAUST FAN CAPABLE OF EXHAUSTING 60 CFM. - ELECTRICAL & PLUMBING WORK TO CONFORM TO THE REPECTIVE CODES. - CONTRACTOR TO CONFIRM ALL LEVELS & DIMENSIONS BEFORE COMMENCING WITH CONSTRUCTION.

- THRMO-PANE WINDOWS THROUGHOUT C/W SCREENS


- Vapour barrier to be continuous and U.V. stabalised. - Provide two coats of bisthumus sealant on all sub-grade concrete' - Confirm all door and window rough openings before ordering product.


- The sheathing lap is to be fastened every 6" with 2 1/4" nails. of 3" d nails @ 10" o.c. to within 6' of each end. Freestanding solid posts:


4. CONCRETE WALL DIMENSIONS ARE TO OUTSIDE OF FACE. WOOD FRAME WALLS ARE TO CENTERLINE.

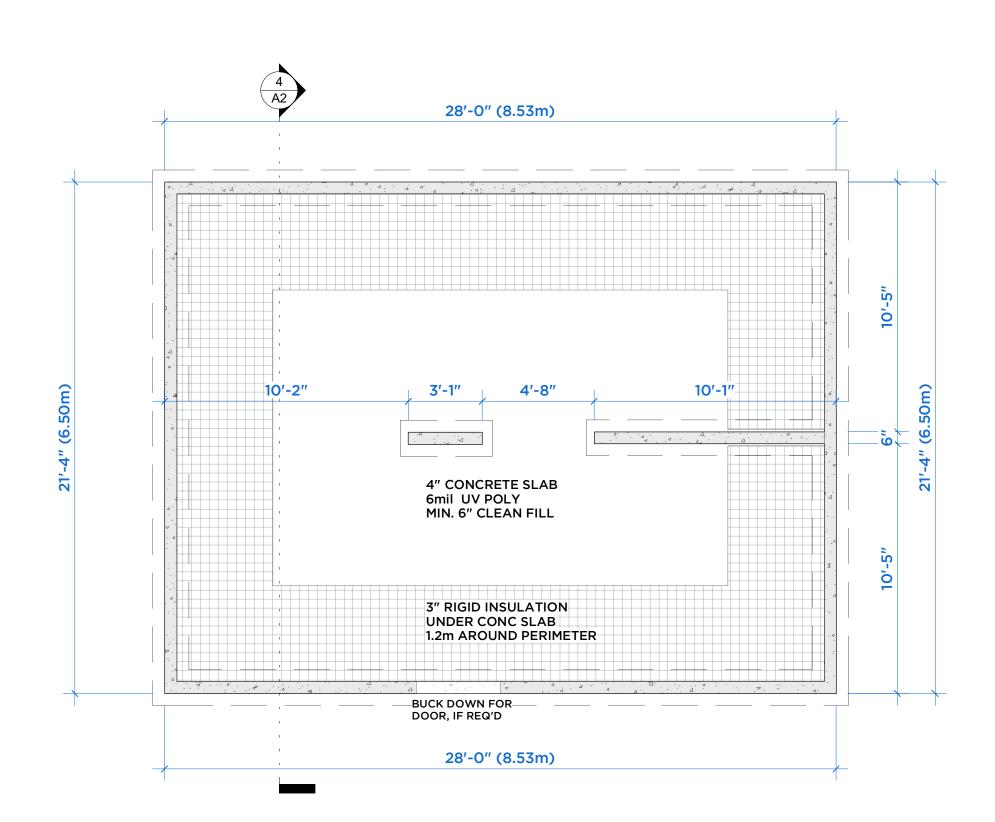


1 Foundation Plan
1/4" = 1'-0"

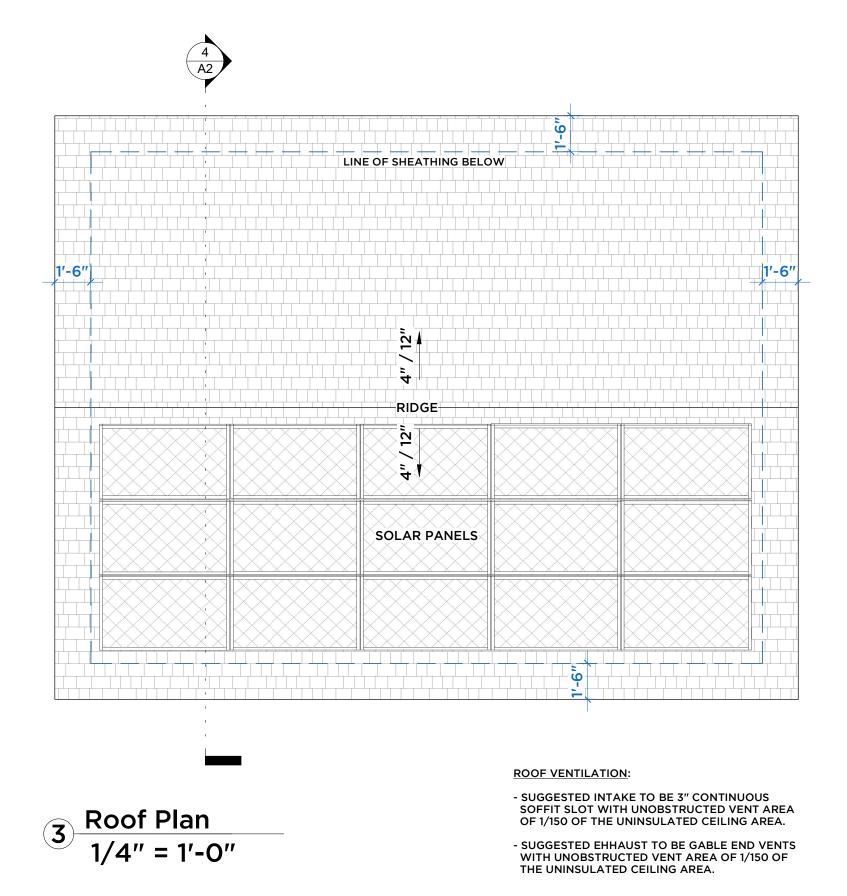


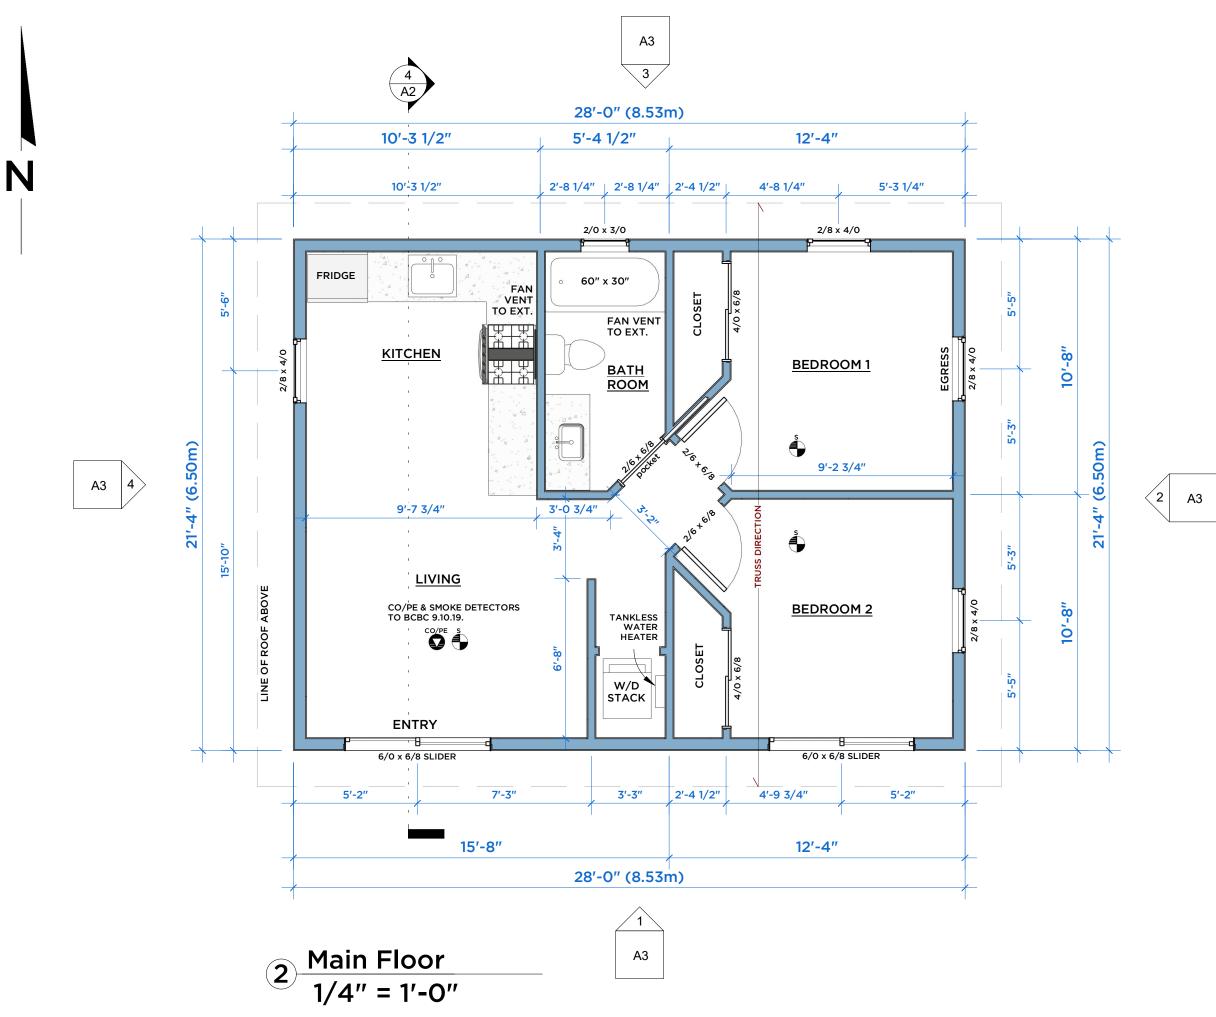


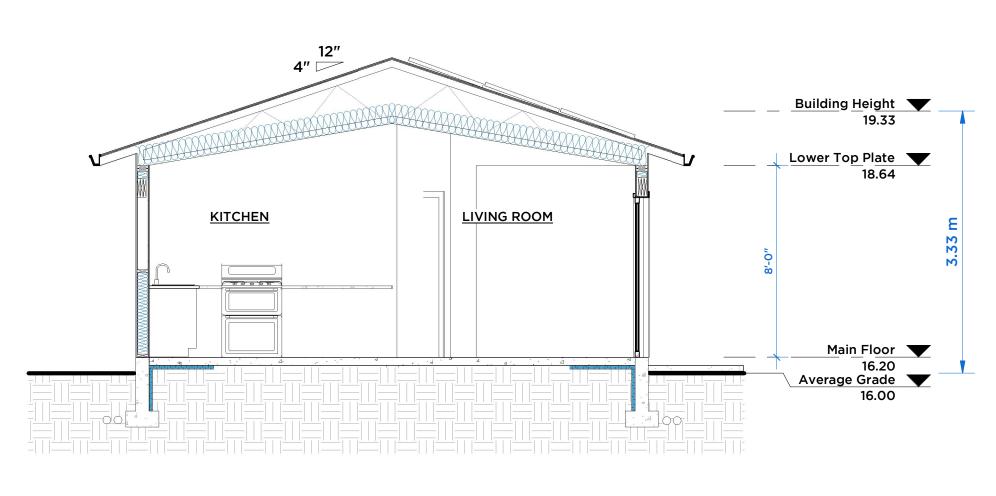

4 Section 1 1/4" = 1'-0"

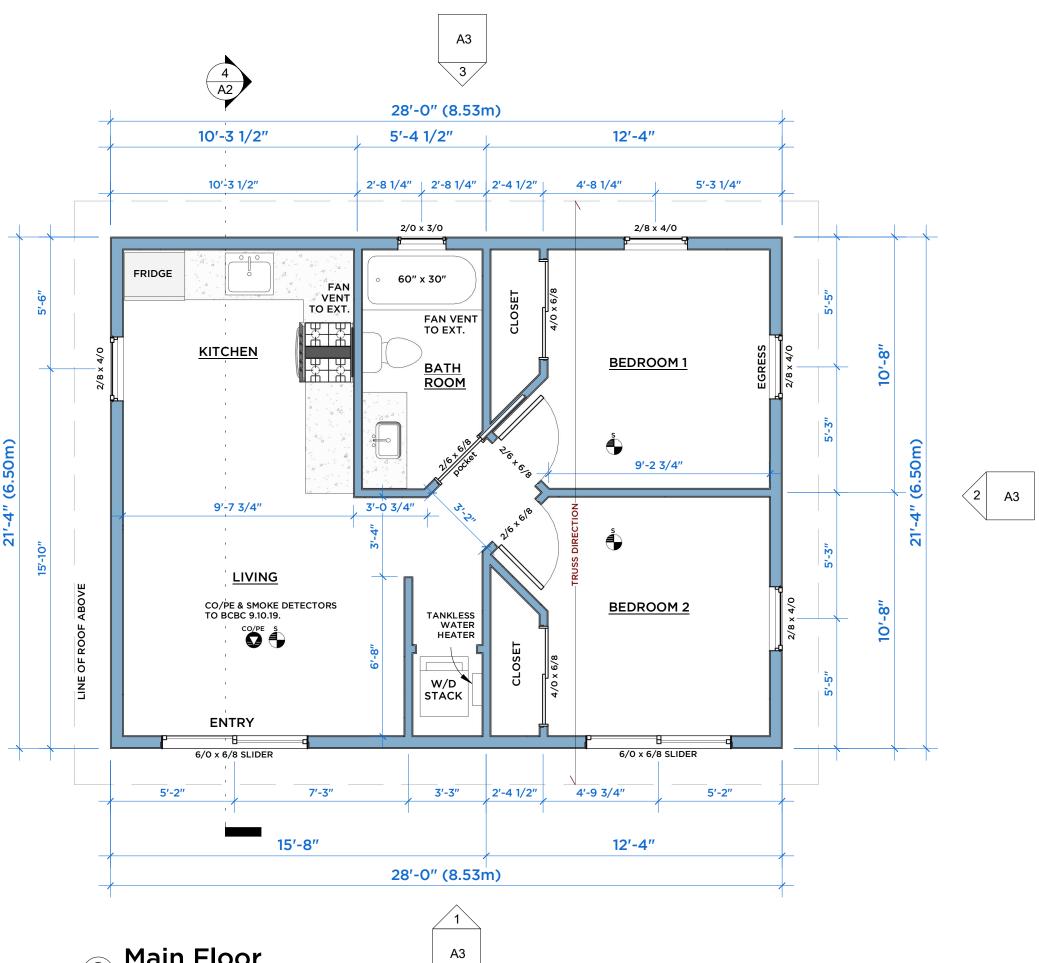

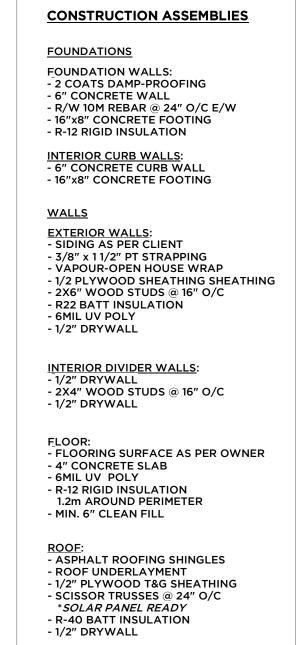

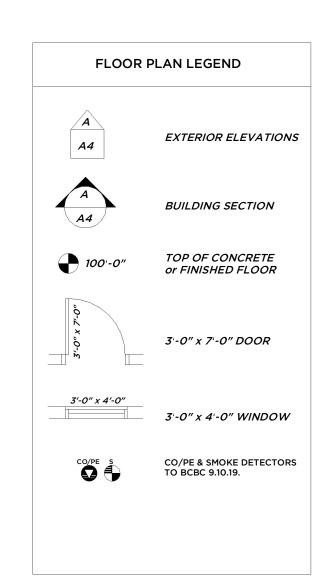



THIS DESIGN IS NOT TO BE REPRODUCED, COPIED OR REUSED WITHOUT THE WRITTEN APPROVAL OF IMMERSIVE DESIGN INC. THIS DESIGN IS TO BE UTILIZED ONLY FOR THE SITE INTENDED AND DESIGNATED ON THE DRAWINGS. IMMERSIVE DESIGN INC. NOR THE DESIGNER/DRAFTSMAN ACCEPT ANY RESPONSIBILITY FOR THE FOLLOWING CONFORMITY OF PLANS TO THE SITE. ERRORS AND OMISSIONS, VARIOUS **ENGINEERING REQUIREMENTS. ANY** HOUSE BUILT FROM THESE PLANS. INFORMATION PROVIDED ON EXISTING BUILDINGS OR SITE. THESE PLANS ARE NOT TO BE REPRODUCED, COPIED OR REUSED WITHOUT THE WRITTEN APPROVAL OF IMMERSIVE DESIGN INC.

Project Name:

Detached Accessory **Dwelling Unit**

1034 DUNSMUIR Road Esquimalt, BC V9A 5C5


Plan Views & Section

Scale: as noted Drawing No.

Drawn by: AJW

A2

Date: APR. 10, 2024 File Name:

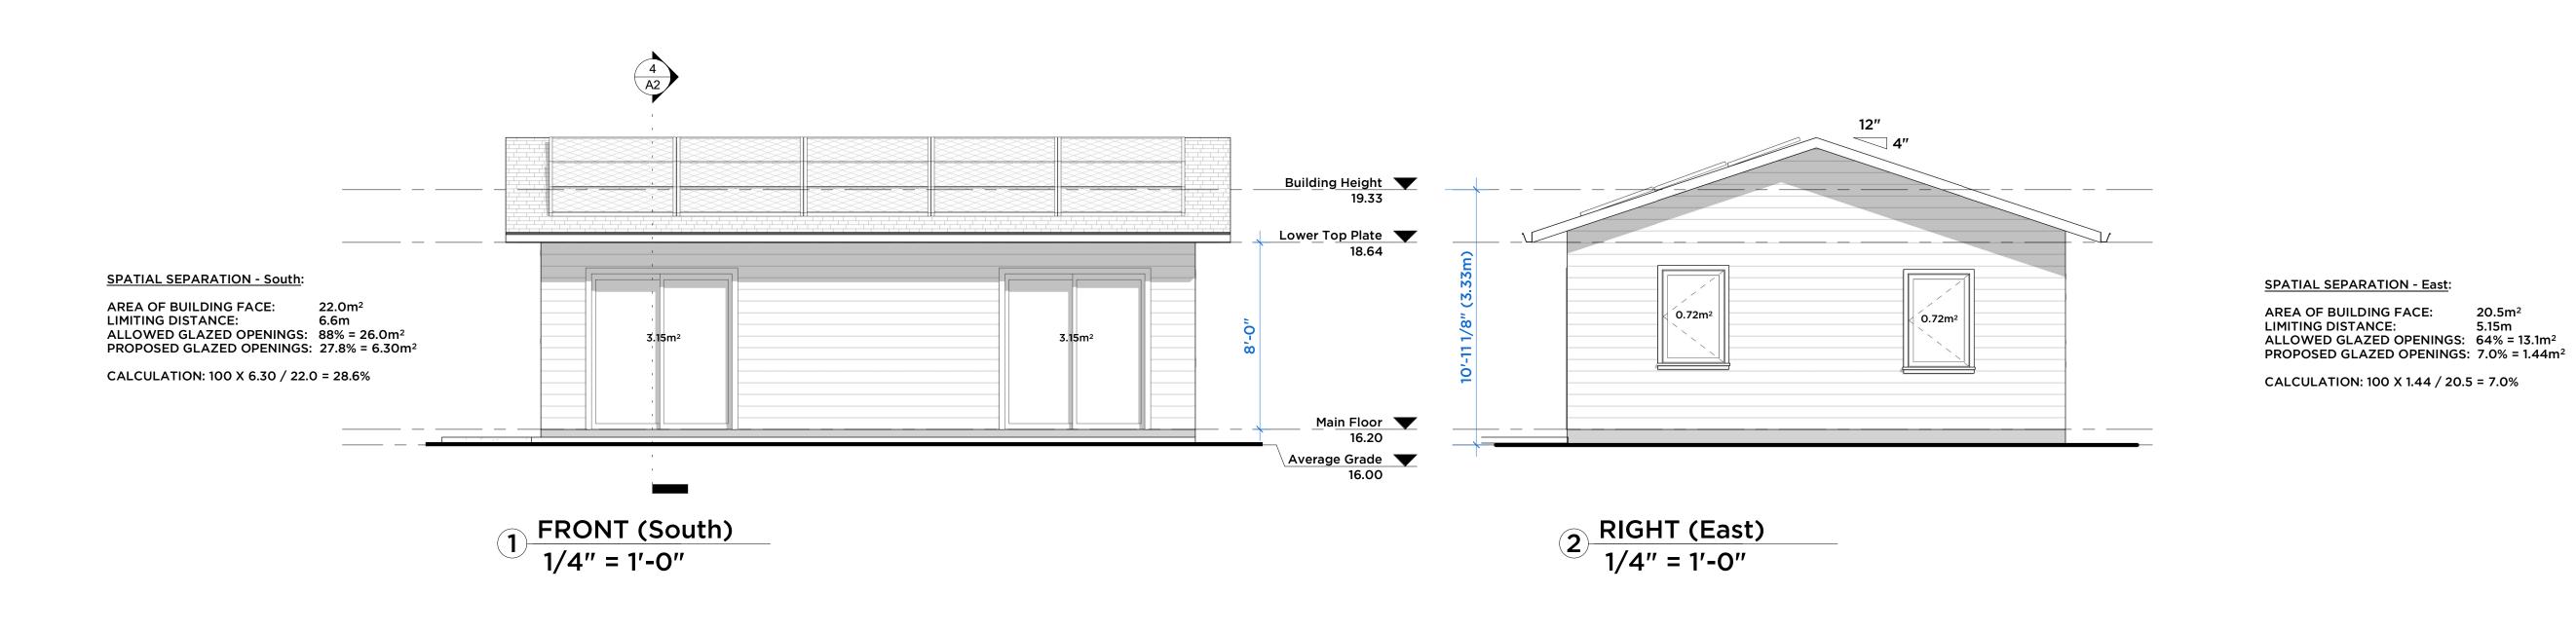



THIS DESIGN IS NOT TO BE REPRODUCED, COPIED OR REUSED WITHOUT THE WRITTEN APPROVAL OF IMMERSIVE DESIGN INC. THIS DESIGN IS TO BE UTILIZED ONLY FOR THE SITE INTENDED AND DESIGNATED ON THE DRAWINGS. IMMERSIVE DESIGN INC. NOR THE DESIGNER/DRAFTSMAN ACCEPT ANY RESPONSIBILITY FOR THE FOLLOWING CONFORMITY OF PLANS TO THE SITE. ERRORS AND OMISSIONS, VARIOUS ENGINEERING REQUIREMENTS. ANY HOUSE BUILT FROM THESE PLANS. INFORMATION PROVIDED ON EXISTING BUILDINGS OR SITE. THESE PLANS ARE NOT TO BE REPRODUCED, COPIED OR REUSED WITHOUT THE WRITTEN APPROVAL OF IMMERSIVE DESIGN INC.

Project Name:

Detached Accessory Dwelling Unit

1034 DUNSMUIR Road Esquimalt, BC V9A 5C5

Elevations

Scale: as noted

Drawn by: AJW

A3 Date: APR. 10, 2024

Drawing No.

File Name:

